
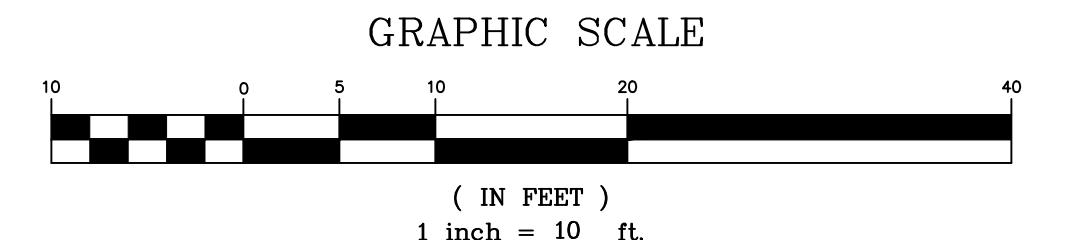


NOTE: THE EXISTING CURB AND SIDEWALK ALONG THE FRONTOAGE OF THE PROPERTY SHALL BE REPLACED PER ADA REQUIREMENTS (MAX. CROSS SLOPE @ 2%).

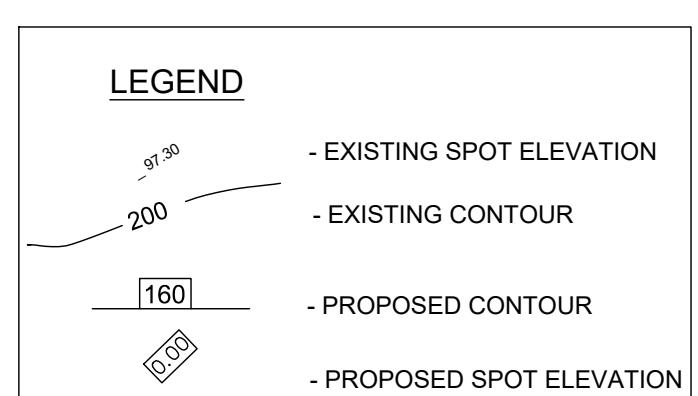

GENERAL NOTES:

1. PARCEL IS KNOWN AS TAX LOT 30 IN BLOCK 14 AS SHOWN ON THE TAX MAPS OF THE TOWN OF HARRISON.
2. AREA OF PARCEL = 7,500 S.F. OR 0.17 ACRES.
3. PARCEL IS LOCATED ENTIRELY IN THE 2F-1 (RESIDENTIAL) DISTRICT AS SHOWN ON THE ZONING MAP OF THE TOWN OF HARRISON.
4. IF THIS DOCUMENT DOES NOT CONTAIN A RAISED IMPRESSION SEAL OF THE PROFESSIONAL, IT IS NOT AN AUTHORIZED ORIGINAL, AND MAY HAVE BEEN ALTERED.
5. THIS IS A GRADING PLAN AND NOT A SURVEY. DO NOT SCALE DRAWINGS FOR LOCATIONS OF ADJACENT STRUCTURES AND SURROUNDING PHYSICAL CONDITIONS. THESE ITEMS MAY BE SCHEMATIC ONLY EXCEPT WHERE DIMENSIONS ARE SHOWN THERETO.
6. THE CONTRACTOR SHALL NOTIFY THE UNDERSIGNED PROFESSIONAL IMMEDIATELY IF ANY FIELD CONDITIONS ENCOUNTERED DIFFER FROM THOSE SHOWN HEREON.
7. ELEVATIONS AND CONTOURS SHOWN ON THIS PLAN ARE BASED ON THE SURVEY PERFORMED AND PROVIDED BY BORRIE, McDONALD & WATSON LAND SURVEYORS OF BLOOMFIELD, NJ, DATED 07/02/2020 AND IS BASED ON NAVD-88.
8. THE PROPOSED SITE PLAN AND BUILDING LAYOUT IS BASED ON THE PLAN PREPARED AND PROVIDED BY NEVES ARCHITECTURE & DESIGN, LLC OF KEARNY, NJ.
9. THE CONTRACTOR SHALL VERIFY ALL UTILITY INFORMATION TO HIS SATISFACTION PRIOR TO COMMENCEMENT OF ANY WORK, THE CONTRACTOR SHALL PERFORM TEST PITS WHERE EXISTING UTILITIES ARE TO BE CROSSED. TEST PIT INFORMATION SHALL BE GIVEN TO THE ENGINEER PRIOR TO CONSTRUCTION TO PERMIT ADJUSTMENTS AS MAY BE REQUIRED TO AVOID CONFLICTS.
10. SITE GRADING AND UTILITY WORK ARE TO BE PERFORMED IN A MANNER TO MINIMIZE DAMAGE TO EXISTING VEGETATION AND TREES. ALL AREAS NOT AFFECTED BY CONSTRUCTION ARE TO REMAIN NATURAL AND UNDISTURBED.
11. NO DETERMINATION WAS MADE AS TO THE PRESENCE OR NONEXISTENCE OF WETLANDS AND/OR HAZARDOUS MATERIALS. THE CLIENT SHOULD PURSUE THESE MATTERS AS ITEMS SEPARATE AND APART FROM THESE PLANS.
12. NO ON-SITE SOIL TESTING AND GROUNDWATER ASSESSMENT HAS BEEN PERFORMED ON THIS PROJECT BY THE DESIGN ENGINEER. IT SHALL BE THE OWNERS AND/OR CONTRACTORS RESPONSIBILITY TO CONDUCT SOIL TESTING AND GROUNDWATER ELEVATION DETERMINATION TO CONFIRM APPLICABILITY OF PROPOSED IMPROVEMENTS, CONSTRUCTABILITY OF THE PROPOSED FINISHED GRADES AND CONSTRUCTION TECHNIQUES WITH RESPECT TO SUBSURFACE SOIL AND GROUNDWATER CONDITIONS.
13. COMPACTING IN FILL AREAS BENEATH ALL PROPOSED UTILITIES AND STRUCTURES SHOULD MEET ALL MANUFACTURERS AND MUNICIPAL REQUIREMENTS AND BE EQUAL TO THE MINIMUM 95% MODIFIED PROCTOR DENSITY.
14. THIS SET OF PLANS HAS BEEN PREPARED FOR PURPOSES OF MUNICIPAL AND AGENCY REVIEW AND APPROVAL. THIS SET OF PLANS SHALL NOT BE UTILIZED AS CONSTRUCTION DOCUMENTS UNTIL ALL CONDITIONS OF APPROVAL HAVE BEEN SATISFIED AND THE DRAWINGS MARKED "ISSUED FOR CONSTRUCTION".
15. ALL MATERIAL, WORKMANSHIP AND CONSTRUCTION FOR SITE IMPROVEMENTS SHOWN HEREON SHALL BE PERFORMED IN STRICT CONFORMANCE WITH:
 - NJDOT "STANDARD SPECIFICATIONS FOR ROAD AND BRIDGE CONSTRUCTION", AS CURRENTLY AMENDED.
 - CURRENT PREVAILING MUNICIPAL AND/OR COUNTY SPECIFICATIONS,
 - STANDARDS, AND REQUIREMENTS.
 - CURRENT PREVAILING UTILITY COMPANY/AUTHORITY SPECIFICATIONS, STANDARDS, AND REQUIREMENTS.
 - "RESIDENTIAL SITE IMPROVEMENT STANDARDS", N.J. ADMINISTRATIVE CODE TITLE 5, CHAPTER 21, AS CURRENTLY AMENDED.
 - STANDARDS AND/OR CONDITIONS OF ANY OTHER GOVERNING BODIES HAVING JURISDICTION.
16. CONSTRUCTION WORK SHALL BE PERFORMED IN ACCORDANCE WITH ALL APPLICABLE SAFETY CODES. APPLICABLE SAFETY CODES SHALL MEAN THE LATEST EDITION INCLUDING ANY AND ALL AMENDMENTS, REVISIONS AND ADDITIONS THERETO OF THE FEDERAL DEPARTMENT OF LABOR, OCCUPATIONAL SAFETY AND HEALTH ADMINISTRATION'S "OCCUPATIONAL SAFETY AND HEALTH STANDARDS" (OSHA); "SAFETY AND HEALTH REGULATIONS FOR CONSTRUCTION" OF THE STATE OF NEW JERSEY, DEPARTMENT OF LABOR AND INDUSTRY, BUREAU OF ENGINEERING AND SAFETY; "CONSTRUCTION SAFETY CODE", AND "MAINTENANCE, CONSTRUCTION AND DEMOLITION," AND "BUILDING CODE".
17. CONSTRUCTION SITE SAFETY IS THE SOLE RESPONSIBILITY OF THE CONTRACTOR, WHO SHALL ALSO BE SOLELY RESPONSIBLE FOR THE MEANS, METHODS, AND SEQUENCING OF CONSTRUCTION OPERATIONS. UNDER NO CIRCUMSTANCES SHOULD THE INFORMATION PROVIDED HERE BE INTERPRETED TO MEAN THAT AWZ ENGINEERING, INC. IS ASSUMING RESPONSIBILITY FOR CONSTRUCTION SITE SAFETY OR THE CONTRACTOR'S ACTIVITIES; SUCH RESPONSIBILITY IS NOT BEING IMPLIED AND SHOULD NOT BE INFERRED.
18. ALL REQUIRED SOIL EROSION AND SEDIMENT CONTROL DEVICES MUST BE INSTALLED PRIOR TO ANY SITE DISTURBANCE. IT SHALL BE THE RESPONSIBILITY OF THE CONTRACTOR TO SUPPLY ANY ADDITIONAL SOIL EROSION & SEDIMENT CONTROL MEASURES AS REQUESTED BY THE GOVERNING SOIL CONSERVATION DISTRICT.
19. TOP SOILING & SEEDING SHALL BE PLACED IN THE AREAS DISTURBED DURING CONSTRUCTION AND / OR AS DIRECTED BY THE ENGINEER.
20. ANY EXISTING CURBS OR OTHER OBJECTS DAMAGED DURING CONSTRUCTION SHALL BE

TAXILOT 30		BLOCK 14	
AWZ ENGINEERING, INC. ENGINEERS • SCIENTISTS • CONSULTANTS Main Office: 150 River Road, Suite B3, Montville, NJ 07045 Pennsylvania Office: Scranton, PA 18504			
29-233 CLEVELAND AVENUE TOWN OF HARRISON HUDSON COUNTY, NEW JERSEY		GRADING PLAN JOB NUMBER: 20-1009 SCALE: AS SHOWN C-01 SHEET 1 OF 1	
ADNAN A. KHAN, P.E., C.M.E. PROFESSIONAL ENGINEER 		DRAWN BY LF DATE: 10/20/20 DESIGNED BY AK DATE: 10/20/20 APPROVED BY AK DATE: 01/13/21 NO. REVISIONS	
N.J. LICENSE NO. 39812 P.A. LICENSE NO. 45052E N.Y. LICENSE NO. 086435 M.D. LICENSE NO. 41803		DATE: 01/13/21 BY: AAK APR: © 2020, AWZ Engineering, Inc. All Rights Reserved. The copying or reuse of this document, or portions thereof, for other than the original project, or purpose originally intended, without the written permission of AWZ Engineering, Inc., is strictly prohibited.	